

LOCATION PLAN

EXISTING FRONT ELEVATION

DRAWING LIST

CONSULTANT	DRAWING No	TITLE	REVISION	DATE
	4251/0	Cover Sheet	J	18/02/2025
Architectural	4251/1	Existing Site Plan	J	18/02/2025
	4251/2	Existing Floor Plan	J	18/02/2025
	4251/3	Ground floor Plan	J	18/02/2025
	4251/4	Upper Floor Plan	J	18/02/2025
	4251/5	Elevations	J	18/02/2025
	4251/6	Sections	J	18/02/2025
	4251/7	Electrical Gound Floor	J	18/02/2025
	4251/8	Electrical Upper Floor	J	18/02/2025
	4251/9	Reflected Ceiling Plan	J	18/02/2025
	4251/10	Gases Plan	J	18/02/2025
	4251/11	Roof Plan	J	18/02/2025
	4251/12	Flooring Layout	J	18/02/2025

Revis	ion		Co
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Н	DA PLANS	12/12/2024]
F	CLIENT CHANGES	28/10/2024	1

P.O. Box 7/79 Toolwoon Bay NSW
PD. 0414 267195 Fax 4332 5888
Email david@paramourtplans.com
DW & SL Baxter Pty Ltd

Project: CHANGE OF USE
RENOVATION OF EXISTING FACTORY
70A - 70B HARLEY CRESCENT
CONDELL PARK
RSPCA NSW SPEY CLINIC

Client:

RSPCA NSW 70A - 70B HARLEY CRESCENT CONDELL PARK Drawing:


COVER SHEET

 Scale
 1:100 @ A1
 Drawn:
 Date:

 1:200 @ A3
 DWB
 28/10/2024

 Revision:
 Date:
 Drawing Number:

 J
 18/02/2025
 4251/0

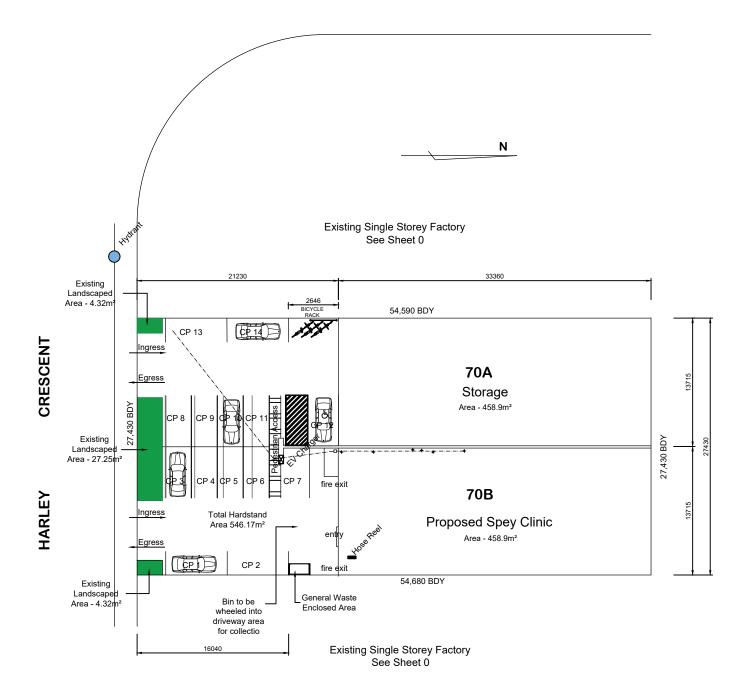

SITE PLAN

Scale 1:250

n		Consultant:
		P.O. Box 7179 Toowoon Bay NSW
		Ph 0414 267135 Fax 4332 5888 Email david@paramountplans.com
		DW & SL Baxter Pty Ltd
DA PLANS	12/12/2024	
CLIENT CHANGES	28/10/2024	ACN 117 933 898

CHANGE OF USE RENOVATION OF EXISTING FACTORY 70A - 70B HARLEY CRESCENT CONDELL PARK **RSPCA NSW SPEY CLINIC**

RSPCA NSW 70A - 70B HARLEY CRESCENT CONDELL PARK

Drawing: SITE PLAN

Scale 1:200 @ A1 1:400 @ A3 Drawn: Date: DWB 28/10/2024 Date: Drawing Number: 4251/1

GENERAL NOTE:

- 1. IT IS THE CONTRACTORS RESPONSIBILITY TO LOCATE ALL EXISTING SERVICES BEFORE COMMENCING ANY DEMOLITION OR CONSTRUCTION WORKS.
 2. SERVICES TO THE AREAS TO BE DEMOLISHED ARE TO BE LOCATED, TERMINATED AND MADE SAFE BEFORE COMMENCEMENT OF DEMOLITION.
 3. ALL DEMOLITION WORKS TO BE CARRIED OUT IN CONJUNCTION WITH AS 2601
 4. SUBMIT A WORK PLAN BEFORE DEMOLITION OR STRIPPING WORK, INCLUDE THE CHECK LIST ITEMS APPROPRIATE TO THE PROJECT FROM AS 2601 APPENDIX A.
 5. PREPARE A HAZARDOUS SUBSTANCE MANAGEMENT PLAN TO AS 2601 CLAUSE 1.6.

- 5. PREPARE A HAZARDOUS SUBSTANCE MANAGEMENT PLAN TO AS 260 I CLAUSE 1.6.

 6. SUBMIT A COPY OF THE DILAPIDATION RECORD FOR INSPECTION.

 7. SUBMIT THE LOCATIONS OF SITE STOCKPILES FOR DEMOLISHED MATERIALS FOR RECYCLING IN THE WORKS. SUBMIT THE NAME AND ADDRESS OF THE PROPOSED RECYCLING FACILITY.

 8. IF TEMPORARY SUPPORT IS REQUIRED, CERTIFICATION FOR ITS DESIGN AND INSTALLATION IS REQUIRED FROM A PROFESSIONAL ENGINEER ENGAGED BY THE CONTRACTOR.

 9. WALL & FLOOR VINYL IN AREAS TO BE DEMOLISHED TO BE REMOVED. ALL GLUE RESIDUE TO BE REMOVED & EXISTING CONCRETE SURFACE & WALL LININGS TO BE PREPARED FOR THE INSTALLATION OF NEW VINYL.

 10. AT THE COMPLETION OF EVERY SUB CONTRACTOR WORKS,
- CONCRETE SURFACE & WALL LININGS TO BE PREPARED FOR THE INSTALLATION OF NEW VINYL.

 10. AT THE COMPLETION OF EVERY SUB CONTRACTOR WORKS, FOR THE WORKS UNDER CONTRACT DURING THE CONSTRUCTION STAGE THE HEAD CONTRACTOR IS TO SUBMIT A STATUARY DECLARATION STATING THAT THE WORKS HAVE BEEN COMPLETED AS PER ALL CONSTRUCTION DOCUMENTATION, AUSTRALIAN STANDARDS AND THE NATIONAL CONSTRUCTION CODE.

 11. IT IS THE HEAD CONTRACTORS RESPONSIBILITY TO ENSURE THAT STAFF AND SUB CONTRACTORS RECEIVE ALL THE TENDER DOCUMENTATION AND ARE FULLY AWARE THAT THE SUB CONTRACTORS TENDER DOCUMENTATION IS TO BE READ IN CONJUNCTION WITH ALL THE SUBMITTED TENDER DOCUMENTS.

 12. IT IS THE HEAD CONTRACTORS RESPONSIBILITY TO ENSURE THAT ALL SUB CONTRACTORS ARE FULLY QUALIFIED AND EXPERIENCED IN ALL ASPECTS OF THE WORKS TO BE CARRIED OUT UNDER CONTRACT.


 13. IT IS THE HEAD CONTRACTORS RESPONSIBILITY TO SUPERVISES SUB CONTRACTORS AT ALL TIMES WHILST PERFORMING THE WORKS NO THE WORK STO BE CONTRACTORS AT ALL TIMES WHILST PERFORMING THE WORKS MODER CONTRACT.

 14. IT IS THE HEAD CONTRACTORS RESPONSIBILITY TO ENSURE THAT THE QUALITY WORKMANSHIP IS OF A HIGH STANDARD, IS CARRIED OUT IN A TRADESMAN LIKE MANNER & THAT ALL MATERIALS SUPPLIED AND INSTALLED BY THE SUB CONTRACTOR SHALL SUPPLIED AND INSTALLED BY THE SUB CONTRACTOR SHALL CHECK ALL RELEVANT


- AS SPECIFIED.

 15. THE HEAD CONTRACTOR SHALL CHECK ALL RELEVANT DIMENSIONS ON SITE BEFORE PROCEEDING WITH WORK UNDER CONTRACT. DRAWINGS ARE NOT TO BE SCATED. IF ANY DESCREPENCIES ARE FOUND BY THE CONTRACTOR OR SUB CONTRACTOR THE SUPERINTENDENT IS TO BE NOTIFIED

 16. OBVIOUS WORKS, IF EITHER DRAWINGS NOR
- OBVIOUS WORKS, IF EITHER DRAWINGS NOR SPECIFICATION CONTAIN ANY MENTION OF METHODS OR PARTS, WHICH IN THE OPINION OF THE PRINCIPAL ARE REASONABLE AND OBVIOUSLY NECESSARY FOR THE SATISFACTORY COMPLETION OF THE WORKS, SUCH METHODS OR PARTS ARE TO9 BE PROVIDED BY THE CONTRACTOR WITHOUT ANY EXTRA CHARGE AS IF THEY WERE SPECIALLY MENTIONED AND SHALL BE DEEMED TO BE, AND HEREBY ARE INCLUDED IN THIS CONTRACT. IT IS THE HEAD CONTRACTORS RESPONSIBILITY TO CLARIFY ALL MENTIOLING METHODS OR DADTE AT THE TENDED STACE. AMBIGUOUS METHODS OR PARTS AT THE TENDER STAGE.
- CONCRETE SCANNING IS TO BE UNDERTAKEN AND ALL IN SLAB DRAINAGE LOCATED, POSITION DOCUMENTED AND SUBMITTED TO THE SUPERINTENDENT FOR APPROVAL BEFORE THE COMMENCEMENT OF CONCRETE CUTTING.

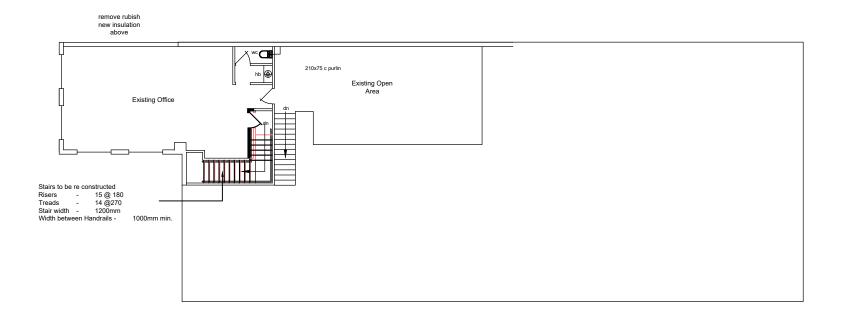


EXISTING UPPER FLOOR PLAN

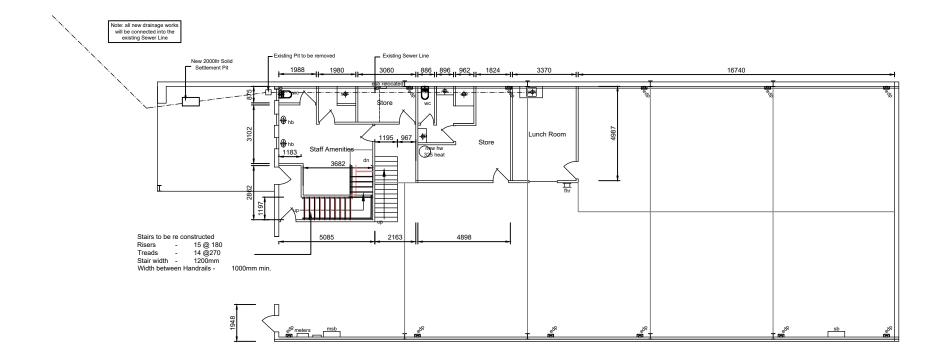


EXISTING GROUND FLOOR PLAN

Revision	Consultant:	Project: CHANGE OF USE	Client:	Drawing:	Scale 4 . 200 @ A4	Drawn:	Date:
	P.O. Bax 7179 Toowoon Bay NSW Ph 0414 267135 Fax 4332 5888 Fmail flavid@naramourthlans.com	RENOVATION OF EXISTING FACTORY	RSPCA NSW	EXISTING FLOOR PLAN	1 : 200 @ A1 1 : 400 @ A3	DWB	28/10/2024
	DW & SL Baxter Pty Ltd	70A - 70B HARLEY CRESCENT CONDELL PARK	70A - 70B HARLEY CRESCENT		Revision:	Date:	Drawing Number:
H DA PLANS 12/12/2024	ACN 117 933 898	RSPCA NSW SPEY CLINIC	CONDELL PARK		J	18/02/2025	4251/2
F CLIENT CHANGES 28/10/2024	-	NOI OF HOM OF EL CEIMIC			1 :		120172

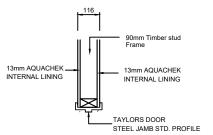

INTERNAL TIMBER FRAME WALL DETAIL **DETAIL - ISF01**

920 leaf door 950 opening

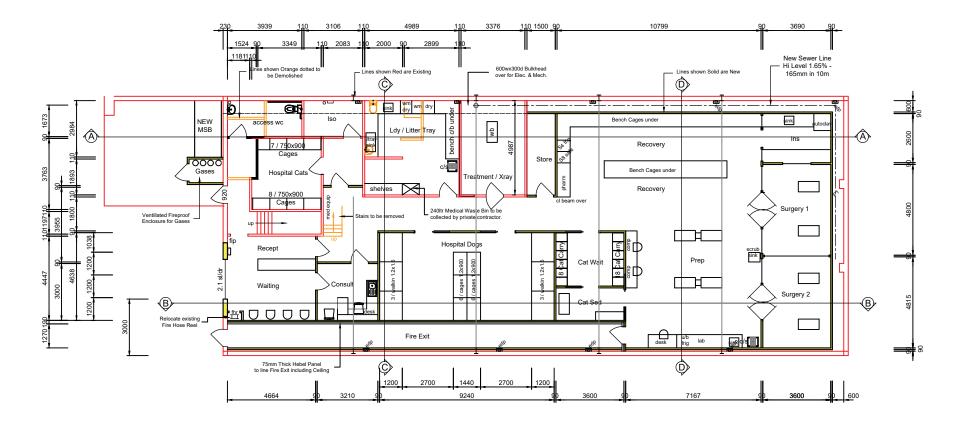

GROUND FLOOR PLAN



12/12/2024 F CLIENT CHANGE

Project: CHANGE OF USE RENOVATION OF EXISTING FACTORY 70A - 70B HARLEY CRESCENT RSPCA NSW SPEY CLINIC

RSPCA NSW 70A - 70B HARLEY CRESCENT CONDELL PARK

GROUND FLOOR PLAN

GENERAL NOTE:

1. IT IS THE CONTRACTORS RESPONSIBILITY TO LOCATE ALL

EXISTING SERVICES BEFORE COMMENCING ANY DEMOLITION OR CONSTRUCTION WORKS. SERVICES TO THE AREAS TO BE DEMOLISHED ARE TO BE LOCATED, TERMINATED AND MADE SAFE BEFORE

SUBMIT A WORK PLAN BEFORE DEMOLITION OR STRIPPING WORK. INCLUDE THE CHECK LIST ITEMS APPROPRIATE TO THE PROJECT FROM AS 2601 APPENDIX A. PREPARE A HAZARDOUS SUBSTANCE MANAGEMENT PLAN

INSPECTION.
SUBMIT THE LOCATIONS OF SITE STOCKPILES FOR
DEMOLISHED MATERIALS FOR RECYCLING IN THE WORKS.
SUBMIT THE NAME AND ADDRESS OF THE PROPOSED
RECYCLING FACILITY.
IF TEMPORARY SUPPORT IS REQUIRED, CERTIFICATION
FOR ITS DESIGN AND INSTALLATION IS REQUIRED FROM A

PROFESSIONAL ENGINEER ENGAGED BY THE CONTRACTOR WALL & FLOOR VINYL IN AREAS TO BE DEMOLISHED TO BE REMOVED. ALL GLUE RESIDUE TO BE REMOVED & EXISTING

REMOVED. ALL GLUE RESIDUE TO BE REMOVED & EXIST. CONCRETE SURFACE & WALL LININGS TO BE PREPARED FOR THE INSTALLATION OF NEW VINYL.

10. IT IS THE HEAD CONTRACTORS RESPONSIBILITY TO ENSURE THAT ALL SUB CONTRACTORS ARE FULLY QUALIFIED AND EXPERIENCED IN ALL ASPECTS OF THE WORKS TO BE CARRIED OUT UNDER CONTRACT WORKS TO BE CARRIED OUT UNDER CONTRACT.

1. IT IS THE HEAD CONTRACTORS RESPONSIBILITY TO SUPERVISE SUB CONTRACTORS AT ALL TIMES WHILST PERFORMING THE WORKS UNDER CONTRACT.

12. IT IS THE HEAD CONTRACTORS RESPONSIBILITY TO ENSURE THAT THE QUALITY WORKMANSHIP IS OF A HIGH CONTRACTORS RESPONSIBILITY TO BE A TRADE OF A HIGH CONTRACTORS RESPONSIBILITY TO BE A WORKMANSHIP IS OF A HIGH CONTRACTOR OF A HIGH CONTR

STANDARD, IS CARRIED OUT IN A TRADESMAN LIKE MANNER & THAT ALL MATERIALS SUPPLIED AND INSTALLED BY THE SUB CONTRACTOR ARE FIT FOR PURPOSE AND ARE

13. CONCRETE SCANNING IS TO BE UNDERTAKEN AND ALL IN SLAB DRAINAGE LOCATED, POSITION DOCUMENTED AND SUBMITTED TO THE SUPERINTENDENT FOR APPROVAL BEFORE THE COMMENCEMENT OF CONCRETE CUTTING.

6. SUBMIT A COPY OF THE DILAPIDATION RECORD FOR

COMMENCEMENT OF DEMOLITION. ALL DEMOLITION WORKS TO BE CARRIED OUT IN

CONJUNCTION WITH AS 2601

TO AS 2601 CLAUSE 1.6.

INSPECTION.

HYDRAULICS NOTE

- PROVIDE A COMPLETE AND OPERATIONAL HYDRAULIC SERVICES SYSTEM TESTED AND COMMISSIONED IN ACCORDANCE WITH AS/NZS 3500 AND THE PLUMBING CODE OF ALISTRALIA
- OF AUSTRALIA.

 12. PROVIDE THE ACCESSORIES AND FITTINGS
 NECESSARY FOR THE PROPER COMMISSIONING OF THE
 SYSTEMS, INCLUDING TAPS, VALVES, OUTLETS, PRESSURE AND
 TEMPERATURE CONTROL DEVICES, STRAINERS AND GAUGES.
 H3. ALL INTERNAL FITTINGS TO HAVE A MINIMUM PRESSURE
- OF 150kPa AND FLOW RATE NOT LESS THAN STATE IN TABLE 3.3 SECTION S OF AS 3500.

 H4. THIS DRAWING TO BE READ INCONJUNCTION WITH THE HYDRAULIC ENGINEERS DRAWINGS.

- M1. ALL ROOMS TO BE MECHANICALLY VENTILAATED.
 STAFF, ANIMAL AREAS VRV TEPERATURE CONTROL
 M2. PROVIDE A COMPLETE AND OPERATIONAL MECHANICAL
- M2. PROVIDE A COMPLETE AND OPERATIONAL MECHANICAL SERVICE AND VENTILLATION SYSTEM TESTED AND COMMISSIONED TO ALL ROOMS OCCUPIED BY A PERSON FOR ANY USE IN ACCORDANCE WITH AS 1668.1, AS 1668.2, AS 3666.1 AND BUILDING CODE OF AUSTRALIA.

 M3 PROVIDE A VENTILLATION AND AIR CONDITIONING SYSTEM CAPABLE OF OPERATING UNDER THE FOLLOWING CLIMATIC CONDITIONS. SUMMER AMBIENT TEMP. 35° Cdb INDOOR DRY BULB TEMP OF 24° C. WINTER AMBIENT TEMP. 6° C db INDOOR DRY BULB TEMP OF 21° C.

 M4. PROVIDE THE VENTILLATION AND AIR CONDITIONING SYSTEM FOR EACH SPACE AND OFFICE. MINIMUM SUPPLY OF 6.0L/s/m². AIR VELOCITY NOT MORE THAN 0.2m/s.

 M5. PROVIDE THE AIR CONDITIONING SYSTEM WHERE THE MAXIMUM SOUND LEVEL B(A) WILL NOT EXCEED 35 dB(A)
- MAXIMUM SOUND LEVEL dB(A) WILL NOT EXCEED 35 dB(A) OFFICES AND ANIMAL ROOMS, 40 dB(A) FOYER AND STAFF

L1. INSTALL HIGH FREQUENCY BALLAST IN FLOURESCENT LI. INSTALL RIGH PREQUENCY BALLAST IN PLOURESCENT LUMINARIES OVER A MINIMIUM OF 95% OF THE NIA.

L2. THE LIGHT DESIGN TO HAVE A MAINTAINED ILLUMINANCE LEVEL OF NO MORE THAN 400 LLX FOR 95% OF THE OFFICE NLA AS MEASURED AT THE WORKING PLANE (720mm AFFL)

L3. LIGHTING POWER DENSITIES FOR 95% OF THE NIA NOT TO EXCEED 1.5 W/m² per 100 LLX AT 720mm AFFL WITH DEFAULT MAINTENANCE FACTOR OF 0.8. L4. INDIVIDUALLY SWITCHED LIGHTING ZONES NOT

EXCEEDING 100m2 FOR 95% OF THE NLA

- ELECTRICAL NOTE
- E1. PROVIDE A COMPLETE AND OPERATIONAL ELECTRICAL SYSTEM TESTED AND COMMISSIONED IN ACCORDANCE WITH AS/NZS 3000 PART 2. AS/NZS 3008.1.1
- PROVIDE A COMPLETE MONITORED AND OPERATIONAL REGENCY LIGHTING SYSTEM IN ACCORDANCE WITH AS/NZS
- PROVIDE A COMPLETE MONOTORED AND OPERATION FIR DECTECTION SYSTEM IN ACCORDANCE WITH AS 1670.

 E4. PROVIDE A COMPLETE AND OPERATIONAL COMUNICATION
- SYSTEM TESTED AND COMMISSIONED IN ACCORDANCE WITH AS/NZS 3080
- ASYNZS JUSU

 ES. PROVIDE A COMPLETE MONITORED AND OPERATIONAL
 SECURITY SYSTEM TESTED AND COMMISSIONED.

 E6. THIS DRAWING TO BE READ IN CONJUNCTION WITH
 ELECTRICAL ENGINEERS DRAWING.

INTERNAL FINISHES SCHEDULE

ITEM		MANUFACTURER	PRODUCT	FINISH	COLOUR	
FLOOR FLOORING		TO ENGINEERS SPEC.	EXIST. REINF. CONCRETE	NA	NA	
		TARKETT	VINYL - EMINENT CHR Value >11.0 kW/m² Smoke Value 117 %.min	R10 100mm Coving	TBS	
WALL	VIEW A					
	VIEW B		SEE STEEL FRAME WALL DETAIL			
	VIEW C		OLE OTELETIONNE WILE DETINE			
	VIEW D	64mm STEEL FRAME				
WALL LINING	VIEW A	CSR	13mm AQUACHEK SMOGRArc <100m²/s² Fire Hazard Group 1	2.0mm Wall Vinyl welded to Floor Cove - 1.0m high Remainder of Wall to be Painted Product Group Classification 3	WHITE	
	VIEW B	CSR	13mm AQUACHEK SMOGRArc <100m²/s² Fire Hazard Group 1	2.0mm Wall Vinyl welded to Floor Cove - 1.0m high Remainder of Wall to be Painted Product Group Classification 3	WHITE	
	VIEW C	CSR	13mm AQUACHEK SMOGRArc <100m²/s² Fire Hazard Group 1	2.0mm Wall Vinyl welded to Floor Cove - 1.0m high Remainder of Wall to be Painted Product Group Classification 3	WHITE	
	VIEW D	CSR	13mm AQUACHEK SMOGRArc <100m²/s² Fire Hazard Group 1	2.0mm Wall Vinyl welded to Floor Cove - 1.0m high Remainder of Wall to be Painted Product Group Classification 3	WHITE	
CEILING		EXISTING	10mm PLASTERBOARD FIXED TO U/S OF STEEL JOISTS	Existing Ceiling Lining to be repaired and made good		
CEILING LINING SURGERIES		CSR	10mm PLASTERBOARD FIXED CEILING SMOGRArc <100m²/s² Fire Hazard Group 1	_		
CEILING LINING EXCEPT SURGERIES		CSR	10mm PLASTERBOARD GRID CEILING SMOGRArc <100m²/s² Fire Hazard Group 1			

Scale 1: 100 @ A1

1:200 @ A3

Drawn:

Date:


DWB

Date:

28/10/2024


Drawing Number:

4251/3

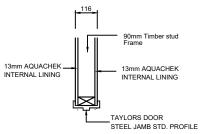

INTERNAL TIMBER FRAME WALL DETAIL DETAIL - ISF01

920 leaf door 950 opening

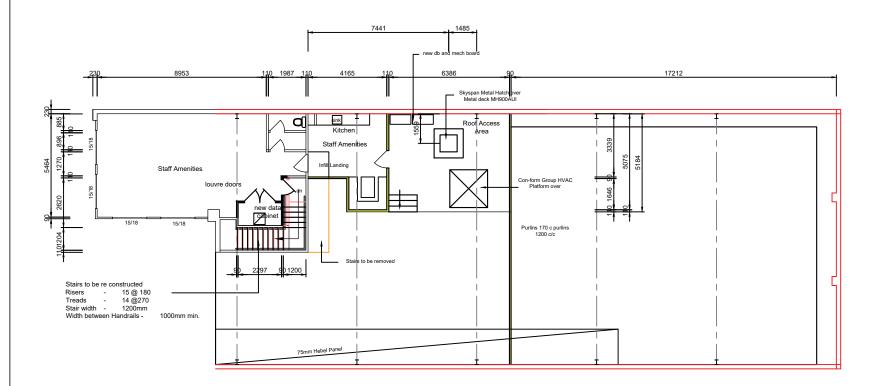

UPPER FLOOR PLAN

Floor Area: 112.60m



12/12/2024 DA PLANS MEZZANINE WINDOWS ADDED 11/11/2024 F CLIENT CHANGES

Project: CHANGE OF USE RENOVATION OF EXISTING FACTORY 70A - 70B HARLEY CRESCENT RSPCA NSW SPEY CLINIC

RSPCA NSW 70A - 70B HARLEY CRESCENT CONDELL PARK

UPPER FLOOR PLAN

GENERAL NOTE:

1. IT IS THE CONTRACTORS RESPONSIBILITY TO LOCATE ALL

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SUBMIT THE LOCATIONS OF SITE STOCKPILES FOR DEMOLISHED MATERIALS FOR RECYCLING IN THE WORKS. SUBMIT THE NAME AND ADDRESS OF THE PROPOSED RECYCLING FACILITY.

IF TEMPORARY SUPPORT IS REQUIRED, CERTIFICATION FOR ITS DESIGN AND INSTALLATION IS REQUIRED FROM A PROSESSED ONLY THE CONTRACTOR A

PROFESSIONAL ENGINEER ENGAGED BY THE CONTRACTOR WALL & FLOOR VINYL IN AREAS TO BE DEMOLISHED TO BE

9. WALL & FLOOR VINYL IN AREAS TO BE DEMOULTABLED TO BE REMOVED & EXISTING CONCRETE SURFACE & WALL LININGS TO BE PREPARED FOR THE INSTALLATION OF NEW VINYL.

10. IT IS THE HEAD CONTRACTORS RESPONSIBILITY TO ENSURE THAT ALL SUB CONTRACTORS ARE FULLY QUALIFIED AND EXPERIENCED IN ALL ASPECTS OF THE WARDLE TO BE CONDITIONAL TO BE CONDITIONAL.

WORKS TO BE CARRIED OUT UNDER CONTRACT.

1. IT IS THE HEAD CONTRACTORS RESPONSIBILITY TO
SUPERVISE SUB CONTRACTORS AT ALL TIMES WHILST
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12. IT IS THE HEAD CONTRACTORS RESPONSIBILITY TO
ENSURE THAT THE QUALITY WORKMANSHIP IS OF A HIGH
STANDARD, IS CARRIED OUT IN A TRADESMAN LIKE

13. CONCRETE SCANNING IS TO BE UNDERTAKEN AND ALL IN SLAB DRAINAGE LOCATED, POSITION DOCUMENTED AND SUBMITTED TO THE SUPERINTENDENT FOR APPROVAL BEFORE THE COMMENCEMENT OF CONCRETE CUTTING.

MANNER & THAT ALL MATERIALS SUPPLIED AND INSTALLED BY THE SUB CONTRACTOR ARE FIT FOR PURPOSE AND ARE

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TO AS 2601 CLAUSE 1.6.
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COMMENCEMENT OF DEMOLITION.

HYDRAULICS NOTE

- PROVIDE A COMPLETE AND OPERATIONAL HYDRAULIC SERVICES SYSTEM TESTED AND COMMISSIONED IN ACCORDANCE WITH AS/NZS 3500 AND THE PLUMBING CODE OF ALISTRALIA
- OF AUSTRALIA.

 12. PROVIDE THE ACCESSORIES AND FITTINGS
 NECESSARY FOR THE PROPER COMMISSIONING OF THE
 SYSTEMS, INCLUDING TAPS, VALVES, OUTLETS, PRESSURE AND
 TEMPERATURE CONTROL DEVICES, STRAINERS AND GAUGES.
 H3. ALL INTERNAL FITTINGS TO HAVE A MINIMUM PRESSURE
- OF 150kPa AND FLOW RATE NOT LESS THAN STATE IN TABLE
- 3.3 SECTION S OF AS 3500.

 H4. THIS DRAWING TO BE READ INCONJUNCTION WITH THE HYDRAULIC ENGINEERS DRAWINGS.

- M1. ALL ROOMS TO BE MECHANICALLY VENTILAATED.
 STAFF, ANIMAL AREAS VRV TEPERATURE CONTROL
 M2. PROVIDE A COMPLETE AND OPERATIONAL MECHANICAL
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 M3 PROVIDE A VENTILLATION AND AIR CONDITIONING SYSTEM CAPABLE OF OPERATING UNDER THE FOLLOWING CLIMATIC CONDITIONS. SUMMER AMBIENT TEMP. 35° Cdb INDOOR DRY BULB TEMP OF 24° C. WINTER AMBIENT TEMP. 6° C db INDOOR DRY BULB TEMP OF 21° C.

 M4. PROVIDE THE VENTILLATION AND AIR CONDITIONING SYSTEM FOR EACH SPACE AND OFFICE. MINIMUM SUPPLY OF 6.0L/s/m². AIR VELOCITY NOT MORE THAN 0.2m/s.

 M5. PROVIDE THE AIR CONDITIONING SYSTEM WHERE THE MAXIMUM SOUND LEVEL B(A) WILL NOT EXCEED 35 dB(A)
- MAXIMUM SOUND LEVEL dB(A) WILL NOT EXCEED 35 dB(A) OFFICES AND ANIMAL ROOMS, 40 dB(A) FOYER AND STAFF

- L1. INSTALL HIGH FREQUENCY BALLAST IN FLOURESCENT LI. INSTALL RIGH PREQUENCY BALLAST IN PLOURESCENT LUMINARIES OVER A MINIMIUM OF 95% OF THE NIA.

 L2. THE LIGHT DESIGN TO HAVE A MAINTAINED ILLUMINANCE LEVEL OF NO MORE THAN 400 LLX FOR 95% OF THE OFFICE NLA AS MEASURED AT THE WORKING PLANE (720mm AFFL)

 L3. LIGHTING POWER DENSITIES FOR 95% OF THE NIA NOT TO EXCEED 1.5 W/m² per 100 LLX AT 720mm AFFL WITH DEFAULT MAINTENANCE FACTOR OF 0.8. L4. INDIVIDUALLY SWITCHED LIGHTING ZONES NOT
- EXCEEDING 100m2 FOR 95% OF THE NLA

ELECTRICAL NOTE

- E1. PROVIDE A COMPLETE AND OPERATIONAL ELECTRICAL SYSTEM TESTED AND COMMISSIONED IN ACCORDANCE WITH AS/NZS 3000 B.AT. 2. AS/NZS 3008 J.I. E2. PROVIDE A COMPLETE MONITORED AND OPERATIONAL EMERGENCY LIGHTING SYSTEM IN ACCORDANCE WITH AS/NZS 203
- PROVIDE A COMPLETE MONOTORED AND OPERATION FIR DECTECTION SYSTEM IN ACCORDANCE WITH AS 1670.
 E4. PROVIDE A COMPLETE AND OPERATIONAL COMUNICATION SYSTEM TESTED AND COMMISSIONED IN ACCORDANCE WITH
- AS/NZS 3080
- ASYNZS JUSU

 ES. PROVIDE A COMPLETE MONITORED AND OPERATIONAL
 SECURITY SYSTEM TESTED AND COMMISSIONED.

 E6. THIS DRAWING TO BE READ IN CONJUNCTION WITH
 ELECTRICAL ENGINEERS DRAWING.

INTERNAL FINISHES SCHEDULE

LOOK		MANUFACTURER	PRODUCT	FINISH	COLOUR	
		TO ENGINEERS SPEC.	EXIST. REINF. CONCRETE	NA	NA	
		TARKETT	VINYL - EMINENT CHR Value >11.0 kW/m² Smoke Value 117 %.min	R10 100mm Coving	TBS	
WALL	VIEW A	64mm STEEL FRAME				
		64mm STEEL FRAME	SEE STEEL FRAME WALL DETAIL			
	VIEW C		OLE OTELETIONNE WALE DETAIL			
	VIEW D	64mm STEEL FRAME				
WALL LINING	VIEW A CSR		13mm AQUACHEK SMOGRArc <100m²/s² Fire Hazard Group 1	2.0mm Wall Vinyl welded to Floor Cove - 1.0m high Remainder of Wall to be Painted Product Group Classification 3	WHITE	
	VIEW B	CSR	13mm AQUACHEK SMOGRArc <100m²/s² Fire Hazard Group 1	2.0mm Wall Vinyl welded to Floor Cove - 1.0m high Remainder of Wall to be Painted Product Group Classification 3	WHITE	
	VIEW C	CSR	13mm AQUACHEK SMOGRArc <100m²/s² Fire Hazard Group 1	2.0mm Wall Vinyl welded to Floor Cove - 1.0m high Remainder of Wall to be Painted Product Group Classification 3	WHITE	
	VIEW D	CSR	13mm AQUACHEK SMOGRArc <100m²/s² Fire Hazard Group 1	2.0mm Wall Vinyl welded to Floor Cove - 1.0m high Remainder of Wall to be Painted Product Group Classification 3	WHITE	
CEILING		EXISTING	10mm PLASTERBOARD FIXED TO U/S OF STEEL JOISTS	Existing Ceiling Lining to be repaired and made good		
CEILING LINING SURGERIES		CSR	10mm PLASTERBOARD FIXED CEILING SMOGRArc <100m²/s² Fire Hazard Group 1			
CEILING LINING EXCEPT SURGERIES		CSR	10mm PLASTERBOARD GRID CEILING SMOGRArc <100m²/s² Fire Hazard Group 1			

Scale 1: 100 @ A1

1:200 @ A3

Drawn:

Date:


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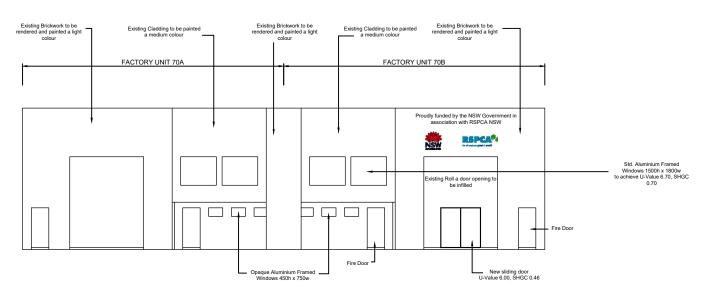
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4251/4







SOUTH ELEVATION


EXTERNAL FINISHES SCHEDULE

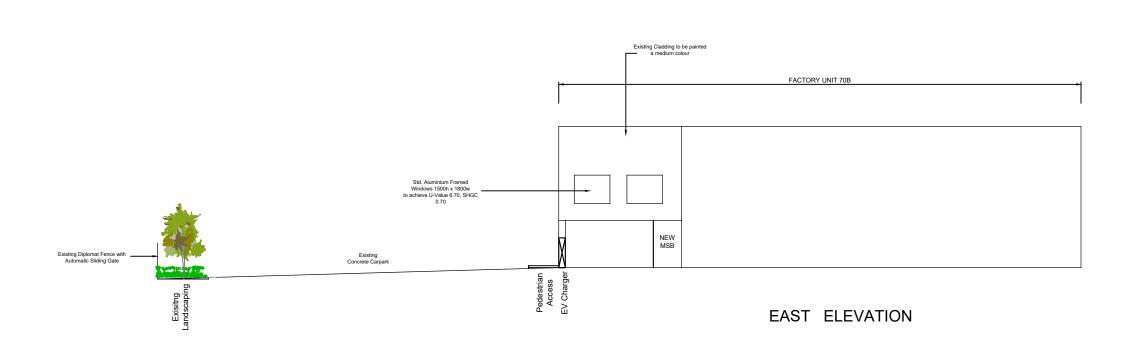ITEM	MANUFACTURER	PRODUCT	FINISH	COLOUR
CLADDING	JAMES HARDIE	VERTCAL CLADDING	PAINTED	DARK GREY
	BORAL	FACE BRICK	RENDERED	OFF WHITE
WINDOWS	EXISTING	ALUMINIUM	POWDERCOAT	BLACK
GUTTER	EXISTING	600 wide x 150 deep	STEEL	NA
ROOFING	EXISTING	TRIMDECK	POWDERCOAT	GREY


Rev	vision		Consultant:		Project: CHANGE OF USE	Client:	Drawing:	Scale 1 100 @ A1	Drawn:	Date:
				P.O. Box 7179 Toowoon Bay NSW Ph 0414 267135 Fax 4332 5888 Email david@paramountplans.com	RENOVATION OF EXISTING FACTORY	RSPCA NSW	ELEVATIONS	1 : 200 @ A3	DWB	28/10/2024
Н		12/12/2024	DW & S	Baxter Pty Ltd	70A - 70B HARLEY CRESCENT CONDELL PARK	70A - 70B HARLEY CRESCENT		Revision:	Date:	Drawing Number:
G	MEZZANINE WINDOWS ADDED 1	11/11/2024		ACN 117 933 898		CONDELL PARK		J	18/02/2025	4251/5
F		28/10/2024	_		RSPCA NSW SPEY CLINIC					7201/0

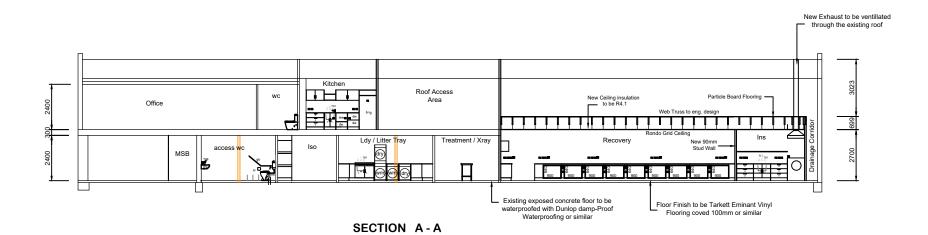

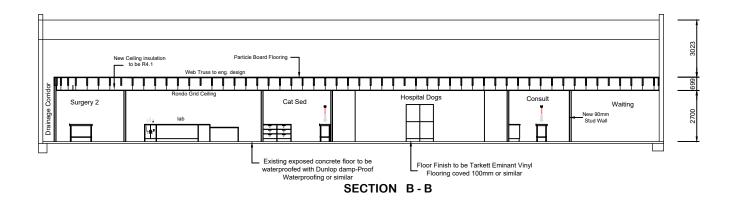

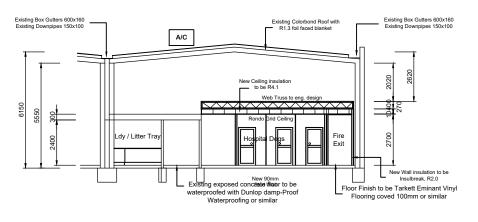

SECTION C-C

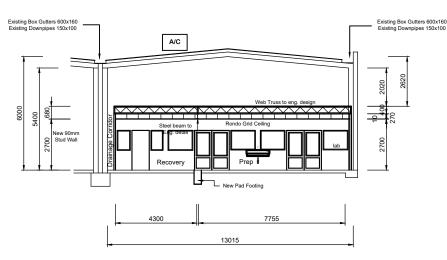

SECTION D-D

INTERNAL FINISHES SCHEDULE

ITEM		MANUFACTURER	PRODUCT	FINISH	COLOUR	
FLOOR FLOORING		TO ENGINEERS SPEC.	EXIST. REINF. CONCRETE	NA	NA	
		TARKETT	VINYL - EMINENT CHR Value >11.0 kW/m² Smoke Value 117 %.min	R10 100mm Coving	TBS	
WALL		64mm STEEL FRAME				
WALL	VIEW B	64mm STEEL FRAME	SEE STEEL FRAME WALL DETAIL			
		64mm STEEL FRAME	OLE OTELETTO WILL WILL BETTER			
	VIEW D	64mm STEEL FRAME				
WALL LINING	VIEW A	CSR	13mm AQUACHEK SMOGRArc <100m²/s² Fire Hazard Group 1	2.0mm Wall Vinyl welded to Floor Cove - 1.0m high Remainder of Wall to be Painted Product Group Classification 3	WHITE	
	VIEW B	CSR	13mm AQUACHEK SMOGRArc <100m²/s² Fire Hazard Group 1	2.0mm Wall Vinyl welded to Floor Cove - 1.0m high Remainder of Wall to be Painted Product Group Classification 3	WHITE	
	VIEW C	CSR	13mm AQUACHEK SMOGRArc <100m²/s² Fire Hazard Group 1	2.0mm Wall Vinyl welded to Floor Cove - 1.0m high Remainder of Wall to be Painted Product Group Classification 3	WHITE	
	VIEW D	CSR	13mm AQUACHEK SMOGRArc <100m²/s² Fire Hazard Group 1	2.0mm Wall Vinyl welded to Floor Cove - 1.0m high Remainder of Wall to be Painted Product Group Classification 3	WHITE	
CEILING		EXISTING	10mm PLASTERBOARD FIXED TO U/S OF STEEL JOISTS	Existing Ceiling Lining to be repaired and made good		
CEILING LINING SURGERIES		CSR	10mm PLASTERBOARD FIXED CEILING SMOGRArc <100m²/s² Fire Hazard Group 1			
CEILING LINING EXCEPT SURGERIES		CSR - SUPATONE	10mm PLASTERBOARD GRID CEILING SMOGRArc <100m²/s² Fire Hazard Group 1			


Revision				
Н	DA PLANS	12/12/2024		
F	CLIENT CHANGES	28/10/2024		



Project: CHANGE OF USE
RENOVATION OF EXISTING FACTORY
70A - 70B HARLEY CRESCENT
CONDELL PARK
RSPCA NSW SPEY CLINIC

RSPCA NSW 70A - 70B HARLEY CRESCENT CONDELL PARK Drawing: SECTIONS 

LIGHTING

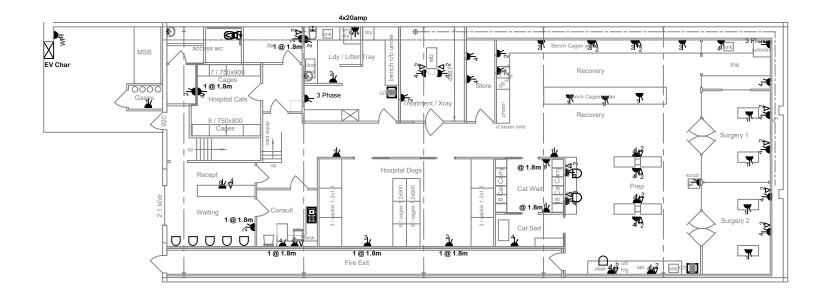

POWER

Revis	ion		Consultant:
			P.O. Box 7179 Toowoon Bay NSW
			Ph 0414 267135 Fax 4332 5888 Email david@paramountplans.com
			DW & SL Baxter Pty Ltd
Н	DA PLANS	12/12/2024	
F	CLIENT CHANGES	28/10/2024	ACN 117 933 898

Project: CHANGE OF USE RENOVATION OF EXISTING FACTORY 70A - 70B HARLEY CRESCENT CONDELL PARK RSPCA NSW SPEY CLINIC

RSPCA NSW 70A - 70B HARLEY CRESCENT CONDELL PARK

Fire Safety Equipment Schedule								
Item	Symbol	Location	Туре	No Off				
FE1	\bigvee	Ldy / Litter	4.5kg ABE Dry Powder Fire Extinguisher	1				
FB1	FB	Ldy / Litter / Kit	Commercial Alumin. Slididing Window	1				
SD1	S	As Shown	Model 885WP-B Weatherproof Heat Dector with Fixed Temperature alarm	1				
FE2		Kitchen	5.0kg Cerbon Dioxide fire Extinguisher	1				
			_					

Lighting Schedule					
Symbol	Item	Description	Photo	No Off	
EM1	Emergency Light	LED Spitfire Emergency Backup Light 2W		20	
ED EXIT	Emergency directional	Thom 96294584 Voyager IP65 Exit 24m E2M	4	9	
EF	Exhaust Fan	Manufacturer: Voltex Model No: DUCTOKIT Warranty: 5 Years		4	
D1 O	Downlight	Clipsal TPDL2K4 Series	The same of the sa	55	
FL1	Flood Light	Clipsal LED TPFLS		2	
	Existing Light	LED Twin 40W Flourescent		25	
(HB)	High Bay Light	Manufacturer: Voltex Model No: HCL-150-CW Warranty: 7 Years D1	څ	6	

Electrical Legend			
2D Symbol	Quantity	Туре	
8	1	Exhaust Fan	
₩	NA	Security Light Censor	
0	1	Downlight	
8	2	Light Switch	
WP	NA	W/P GPO	
21/	3	DGPO	
sd	NA	Smoke Detector	

HYDRAULICS NOTE

H1. PROVIDE A COMPLETE AND OPERATIONAL HYDRAULIC

H1. PROVIDE A COMPLETE AND OPERATIONAL HYDRAULIC SERVICES SYSTEM TESTED AND COMMISSIONED IN ACCORDANCE WITH AS/NZS 3500 AND THE PLUMBING CODE OF AUSTRALIA.

H2. PROVIDE THE ACCESSORIES AND FITTINGS NECESSARY FOR THE PROPER COMMISSIONING OF THE SYSTEMS, INCLUDING TAPS, VALVES, OUTLETS, PRESSURE AND TEMPERATURE CONTROL DEVICES CITALINERS AND CAUSES SYSTEMS, INCLUDING TAPS, VALVES, OUTLETS, PRESSURE AND TEMPERATURE CONTROL DEVICES, STRAILERS AND GAUGES.

H3. ALL INTERNAL FITTINGS TO HAVE A MINIMUM PRESSURE OF 150kPa AND FLOW RATE NOT LESS THAN STATE IN TABLE 3.3 SECTION S OF AS 3500.

H4. THIS DRAWING TO BE READ INCONJUNCTION WITH THE HYDRAULIC ENGINEERS DRAWINGS.

MECHANICAL NOTE

M1. ALL ROOMS TO BE MECHANICALLY VENTILAATED.
STAFF, ANIMAL AREAS VRV TEPERATURE CONTROL
M2. PROVIDE A COMPLETE AND OPERATIONAL MECHANICAL
SERVICE AND VENTILATION SYSTEM TESTED AND
COMMISSIONED TO ALL ROOMS OCCUPIED BY A PERSON FOR ANY USE IN ACCORDANCE WITH AS 1668.1, AS 1668.2, AS 3666.1 AND BUILDING CODE OF AUSTRALIA.

M3 PROVIDE A VENTILLATION AND AIR CONDITIONING M3 PROVIDE A VENTILLATION AND AIR CONDITIONING SYSTEM CAPABLE OF OPERATING UNDER THE FOLLOWING CLIMATIC CONDITIONS. SUMMER AMBIENT TEMP. 35° Cdb - INDOOR DRY BULB TEMP OF 24° C. WINTER AMBIENT TEMP. 6° C db - INDOOR DRY BULB TEMP 21° C.

M4. PROVIDE THE VENTILLATION AND AIR CONDITIONING SYSTEM FOR EACH SPACE AND OFFICE. MINIMUM SUPPLY OF 6.0L/s/m². AIR VELOCITY NOT MORE THAN 0.2m/s.

M5. PROVIDE THE AIR CONDITIONING SYSTEM WHERE THE MAXIMUM SOUND LEVEL dB(A) WILL NOT EXCEED 35 dB(A) OFFICES AND ANIMAL ROOMS, 40 dB(A) FOYER AND STAFF ROOM.

LIGHTING NOTE

L1. INSTALL HIGH FREQUENCY BALLAST IN FLOURESCENT LUMINARIES OVER A MINIMIUM OF 95% OF THE NLA.

L2. THE LIGHT DESIGN TO HAVE A MAINTAINED ILLUMINANCE LEVEL OF NO MORE THAN 400 Lux FOR 95% OF THE OFFICE NLA AS MEASURED AT THE WORKING PLANE (720mm AFFL)

L3. LIGHTING POWER DENSITIES FOR 95% OF THE NLA NOT AS A CONTRACTOR OF THE NLA NOT AS A TO EXCEED 1.5 w/m² per 100 Lux AT 720mm AFFL WITH DEFAULT MAINTENANCE FACTOR OF 0.8. L4. INDIVIDUALLY SWITCHED LIGHTING ZONES NOT EXCEEDING 100m² FOR 95% OF THE NLA.

FLECTRICAL NOTE


E1. PROVIDE A COMPLETE AND OPERATIONAL ELECTRICAL SYSTEM TESTED AND COMMISSIONED IN ACCORDANCE WITH AS/NZS 3000 PART 2. AS/NZS 3008.1.1 E2. PROVIDE A COMPLETE MONITORED AND OPERATIONAL EMERCENCY LIGHTING SYSTEM IN ACCORDANCE WITH AS/NZS

E3. PROVIDE A COMPLETE MONOTORED AND OPERATION FIRE E3. PROVIDE A COMPLETE MONOTORED AND OPERATION FIRE DECTECTION SYSTEM IN ACCORDANCE WITH AS 1670.

E4. PROVIDE A COMPLETE AND OPERATIONAL COMUNICATIONS SYSTEM TESTED AND COMMISSIONED IN ACCORDANCE WITH AS/NZS 3080

E5. PROVIDE A COMPLETE MONITORED AND OPERATIONAL SECURITY SYSTEM TESTED AND COMMISSIONED.

E6. THIS DRAWING TO BE READ IN CONJUNCTION WITH ELECTRICAL ENGINEERS DRAWING.

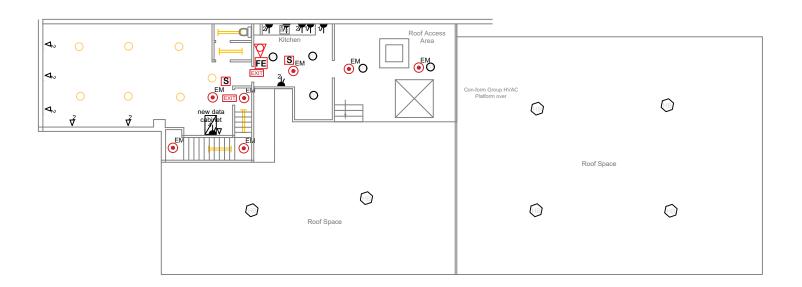

LIGHTING AND POWER

Fire Safety Equipment Schedule				
Item	Symbol	Location	Туре	No Off
FE1	∇	Ldy / Litter	4.5kg ABE Dry Powder Fire Extinguisher	1
FB1	FB	Ldy / Litter / Kit	Commercial Alumin. Slididing Window	1
SD1	S	As shown	Model 885WP-B Weatherproof Heat Dector with Fixed Temperature alarm	1
FE2	A	Kitchen	5.0kg Cerbon Dioxide fire Extinguisher	1

Lighting Schedule					
Symbol	Item	Description	Photo	No Off	
EM1	Emergency Light	LED Spitfire Emergency Backup Light 2W		20	
ED EXIT	Emergency directional	Thom 96294584 Voyager IP65 Exit 24m E2M	3	9	
EF	Exhaust Fan	Manufacturer: Voltex Model No: DUCTOKIT Warranty: 5 Years		4	
Ö	Downlight	Clipsal TPDL2K4 Series	Marie Contraction of the Contrac	55	
FL1	Flood Light	Clipsal LED TPFLS		2	
	Existing Light	LED Twin 40W Flourescent		25	
HB	High Bay Light	Manufacturer: Voltex Model No: HCL-150-CW Warranty: 7 Years D1	Å	6	

Electrical Legend			
2D Symbol	Quantity	Туре	
3	1	Exhaust Fan	
-•€	NA	Security Light Censor	
0	1	Downlight	
8	2	Light Switch	
WP	NA	W/P GPO	
21/	3	DGPO	
sd	NA	Smoke Detector	

HYDRAULICS NOTE

H1. PROVIDE A COMPLETE AND OPERATIONAL HYDRAULIC SERVICES SYSTEM TESTED AND COMMISSIONED IN ACCORDANCE WITH AS/NZS 3500 AND THE PLUMBING CODE OF AUSTRALIA.

H2. PROVIDE THE ACCESSORIES AND FITTINGS NECESSARY FOR THE PROPER COMMISSIONING OF THE SYSTEMS, INCLUDING TAPS, VALVES, OUTLETS, PRESSURE AND TEMPERATURE CONTROL DEVICES, STRAINERS AND GAUGES.
H3. ALL INTERNAL FITTINGS TO HAVE A MINIMUM PRESSURE OF 150kPa AND FLOW RATE NOT LESS THAN STATE IN TABLE 3.3 SECTION S OF A S 3500.

H4. THIS DRAWING TO BE READ INCONJUNCTION WITH THE HYDRAULIC ENGINEERS DRAWINGS.

MECHANICAL NOTE

M1. ALL ROOMS TO BE MECHANICALLY VENTILAATED.
STAFF, ANIMAL AREAS VRV TEPERATURE CONTROL
M2. PROVIDE A COMPLETE AND OPERATIONAL MECHANICAL
SERVICE AND VENTILLATION SYSTEM TESTED AND
COMMISSIONED TO ALL ROOMS OCCUPIED BY A PERSON FOR
ANY USE IN ACCORDANCE WITH AS 1668.1, AS 1668.2, AS
3666.1 AND BUILDING CODE OF AUSTRALIA.
M3. PROVIDE A VENTILLATION AND AIR CONDITIONING M3 PROVIDE A VENTILLATION AND AIR CONDITIONING SYSTEM CAPABLE OF OPERATING UNDER THE FOLLOWING CLIMATIC CONDITIONS. SUMMER AMBIENT TEMP. 35° Cdb - INDOOR DRY BUILB TEMP OF 24° C. WINTER AMBIENT TEMP. 6° C db - INDOOR DRY BUILB TEMP 21° C. M4. PROVIDE THE VENTILLATION AND AIR CONDITIONING SYSTEM FOR EACH SPACE AND OFFICE. MINIMUM SUPPLY OF 6.0L/s/m². AIR VELOCITY NOT MORE THAN 0.2m/s. M5. PROVIDE THE AIR CONDITIONING SYSTEM WHERE THE MAXIMUM SOUND LEVEL dB(A) WILL NOT EXCEED 35 dB(A) OFFICES AND ANIMAL ROOMS, 40 dB(A) FOYER AND STAFF ROOM.

LIGHTING NOTE

L1. INSTALL HIGH FREQUENCY BALLAST IN FLOURESCENT LUMINARIES OVER A MINIMIUM OF 95% OF THE NLA.
L2. THE LIGHT DESIGN TO HAVE A MAINTAINED ILLUMINANCE LEVEL OF NO MORE THAN 400 Lux FOR 95% OF THE OFFICE NLA AS MEASURED AT THE WORKING PLANE (720mm AFFL)
L3. LIGHTING POWER DENSITIES FOR 95% OF THE NLA NOT TO EYCEPL 1.5 M/m 20 pt. 100 Lux AT 720mm AFFL WITH TO EXCEED 1.5 w/m² per 100 Lux AT 720mm AFFL WITH DEFAULT MAINTENANCE FACTOR OF 0.8. L4. INDIVIDUALLY SWITCHED LIGHTING ZONES NOT EXCEEDING 100m² FOR 95% OF THE NLA.

FLECTRICAL NOTE

E1. PROVIDE A COMPLETE AND OPERATIONAL ELECTRICAL SYSTEM TESTED AND COMMISSIONED IN ACCORDANCE WITH AS/NZS 3000 PART 2. AS/NZS 3008.1.1 E2. PROVIDE A COMPLETE MONITORED AND OPERATIONAL EMERGENCY LIGHTING SYSTEM IN ACCORDANCE WITH AS/NZS 2322

2293.
E3. PROVIDE A COMPLETE MONOTORED AND OPERATION FIRE DECTECTION SYSTEM IN ACCORDANCE WITH AS 1670.
E4. PROVIDE A COMPLETE AND OPERATIONAL COMUNICATIONS SYSTEM TESTED AND COMMISSIONED IN ACCORDANCE WITH AS/NZS 3080
E5. PROVIDE A COMPLETE MONITORED AND OPERATIONAL SECURITY SYSTEM TESTED AND COMMISSIONED.
E6. THIS DRAWING TO BE READ IN CONJUNCTION WITH ELECTRICAL ENGINEERS DRAWING.


F CLIENT CHANGES


Project: CHANGE OF USE RENOVATION OF EXISTING FACTORY 70A - 70B HARLEY CRESCENT CONDELL PARK RSPCA NSW SPEY CLINIC

RSPCA NSW 70A - 70B HARLEY CRESCENT CONDELL PARK

ELECTRICAL PLAN UPPER FLOOR

Scale 1: 100 @ A1	Drawn:	Date:
1 : 200 @ A3	DWB	28/10/2024
Revision:	Date:	Drawing Number:
J	18/02/2025	4251/8

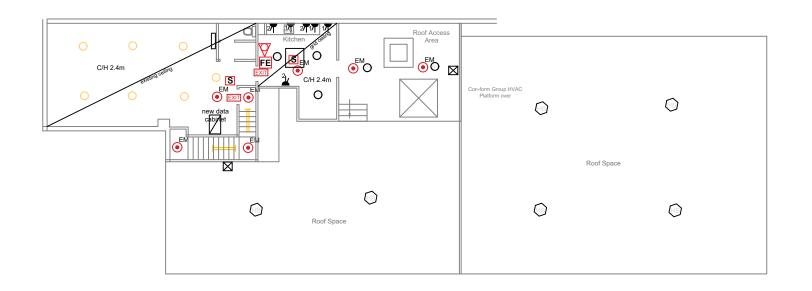

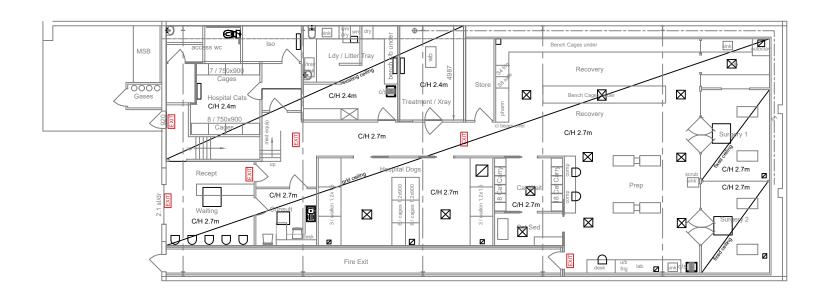

HVAC Split system HVAC Exhaust

Hvac Supply

HVAC Cassette


Revision			
Н	DA PLANS	12/12/2024	
F	CLIENT CHANGES	28/10/2024	

Project: CHANGE OF USE RENOVATION OF EXISTING FACTORY 70A - 70B HARLEY CRESCENT CONDELL PARK RSPCA NSW SPEY CLINIC

RSPCA NSW 70A - 70B HARLEY CRESCENT CONDELL PARK

REFLECTED CEILING PLAN

Scale 1:100 @ A1 1:200 @ A3 Date: Drawn: DWB 28/10/2024 Drawing Number: Date: 4251/9

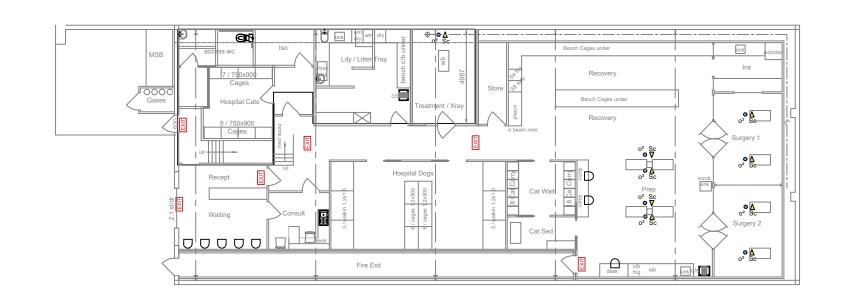





Active Scavenger

Revisi	on	
Н	DA PLANS	12/12/2024
F	CLIENT CHANGES	28/10/2024

P.O. Box 7179 Towcon Bay NSW
Ph. 0442 287135 Fax 4332 5888
Email david@ovarmountplans.com
DW & SL Baxter Pty Ltd
ACK 117 233 888

Project: CHANGE OF USE
RENOVATION OF EXISTING FACTORY
70A - 70B HARLEY CRESCENT
CONDELL PARK
RSPCA NSW SPEY CLINIC

RSPCA NSW 70A - 70B HARLEY CRESCENT CONDELL PARK Drawing: GASES PLAN
 Scale
 1:100 @ A1
 Drawn:
 Date:


 1:200 @ A3
 DWB
 28/10/2024

 Revision:
 Date:
 Drawing Number:

 J
 18/02/2025
 4251/10

GENERAL NOTE:

- SOLAR PANELS AND INVERTER TO BE INSTALLED TO MANUFACTURERS SPECIFICATION.
 SOLAR POWER TO BE UTILISED DURING THE DAY WITH NO BATTERY BACKUP INSTALLED.

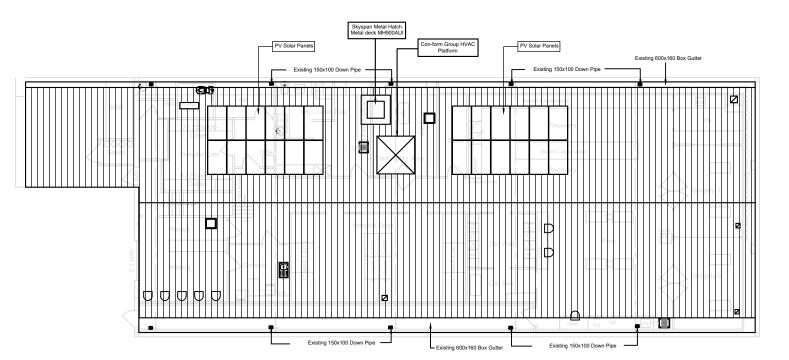


Existing 150x100 Down Pipe

Revis	Revision			
Н	DA PLANS	12/12/2024		
F	CLIENT CHANGES	28/10/2024		


Project: CHANGE OF USE RENOVATION OF EXISTING FACTORY 70A - 70B HARLEY CRESCENT CONDELL PARK RSPCA NSW SPEY CLINIC

RSPCA NSW 70A - 70B HARLEY CRESCENT CONDELL PARK

Drawing: **ROOF PLAN** Scale 1:100 @ A1 1:200 @ A3 Drawn: Date: DWB 28/10/2024 Drawing Number: Date: 4251/11

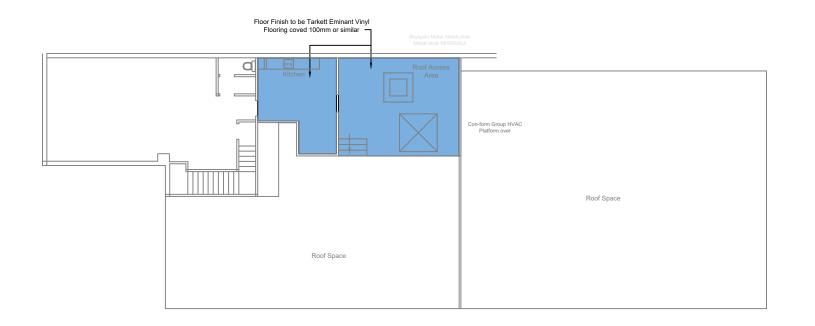

LIGHTING AND POWER

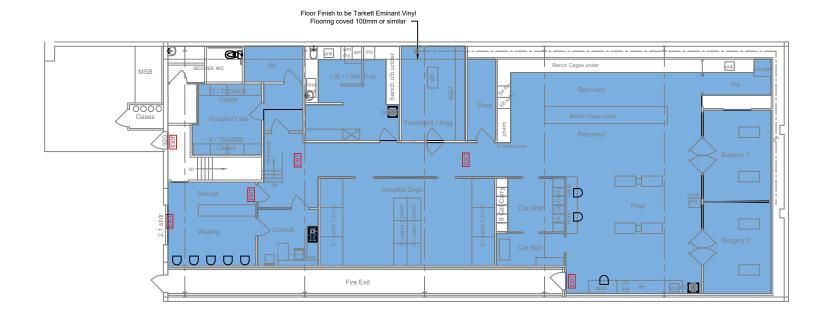

GENERAL NOTE:

- 1. IT IS THE CONTRACTORS RESPONSIBILITY TO LOCATE ALL EXISTING SERVICES BEFORE COMMENCING ANY DEMOLITION OR CONSTRUCTION WORKS.
 2. SERVICES TO THE AREAS TO BE DEMOLISHED ARE TO BE LOCATED, TERMINATED AND MADE SAFE BEFORE COMMENCEMENT OF DEMOLITION.
 3. ALL DEMOLITION WORKS TO BE CARRIED OUT IN CONJUNCTION WITH AS 2601
 4. SUBMIT A WORK PLAN BEFORE DEMOLITION OR STRIPPING WORK. INCLUDE THE CHECK LIST ITEMS APPROPRIATE TO THE PROJECT FROM AS 2601 APPENDIX A.
 5. PREPARE A HAZARDOUS SUBSTANCE MANAGEMENT PLAN TO AS 2601 CLAUSE 1.6.
 6. SUBMIT A COPY OF THE DILAPIDATION RECORD FOR INSPECTION.
- INSPECTION.
 SUBMIT THE LOCATIONS OF SITE STOCKPILES FOR

- INSPECTION.

 7. SUBMIT THE LOCATIONS OF SITE STOCKPILES FOR DEMOLISHED MATERIALS FOR RECYCLING IN THE WORKS. SUBMIT THE NAME AND ADDRESS OF THE PROPOSED RECYCLING FACILITY.

 8. IF TEMPORARY SUPPORT IS REQUIRED, CERTIFICATION FOR ITS DESIGN AND INSTALLATION IS REQUIRED FROM A PROFESSIONAL ENGINEER ENGAGED BY THE CONTRACTOR.

 9. WALL & FLOOR VINYL IN AREAS TO BE DEMOLISHED TO BE REMOVED. ALL GLUE RESIDUE TO BE REMOVED & EXISTING CONCRETE SURFACE & WALL LININGS TO BE PREPARED FOR THE INSTALLATION OF NEW VINYL.

 10. IT IS THE HEAD CONTRACTORS RESPONSIBILITY TO ENSURE THAT ALL SUB CONTRACTORS ARE FULLY QUALIFIED AND EXPERIENCED IN ALL ASPECTS OF THE WORKS TO BE CARRIED OUT UNDER CONTRACT.

 11. IT IS THE HEAD CONTRACTORS AT ALL TIMES WHILST PERFORMING THE WORKS MODER CONTRACT.

 12. IT IS THE HEAD CONTRACTORS AT ALL TIMES WHILST PERFORMING THE WORKS UNDER CONTRACT.

 13. IT IS THE HEAD CONTRACTORS RESPONSIBILITY TO ENSURE THAT ALL MATERIALS SUPPLIED AND INSTALLED BY THE SUB CONTRACTOR ARE FULLY PLANTAGE.
- BY THE SUB CONTRACTOR ARE FIT FOR PURPOSE AND ARE AS SPECIFIED.

 13. CONCRETE SCANNING IS TO BE UNDERTAKEN AND ALL IN SLAB DRAINAGE LOCATED, POSITION DOCUMENTED AND SUBMITTED TO THE SUPERINTENDENT FOR APPROVAL BEFORE THE COMMENCEMENT OF CONCRETE CUTTING.

Revision		
Н	DA PLANS	12/12/2024
_	CLIENT CHANGES	28/10/2024

Project: CHANGE OF USE RENOVATION OF EXISTING FACTORY 70A - 70B HARLEY CRESCENT CONDELL PARK RSPCA NSW SPEY CLINIC

RSPCA NSW 70A - 70B HARLEY CRESCENT CONDELL PARK

Drawing: FLOORING LAYOUT Scale 1:100@A1 1:200@A3 Drawn: Date: DWB 28/10/2024 Date: Drawing Number: 4251/12